

AMENTA EMMA






LEXINGTON PARTNERS,

ONE PARK ROAD

27 PARK ROAD WEST HARTFORD, CT

CONSULTANTS



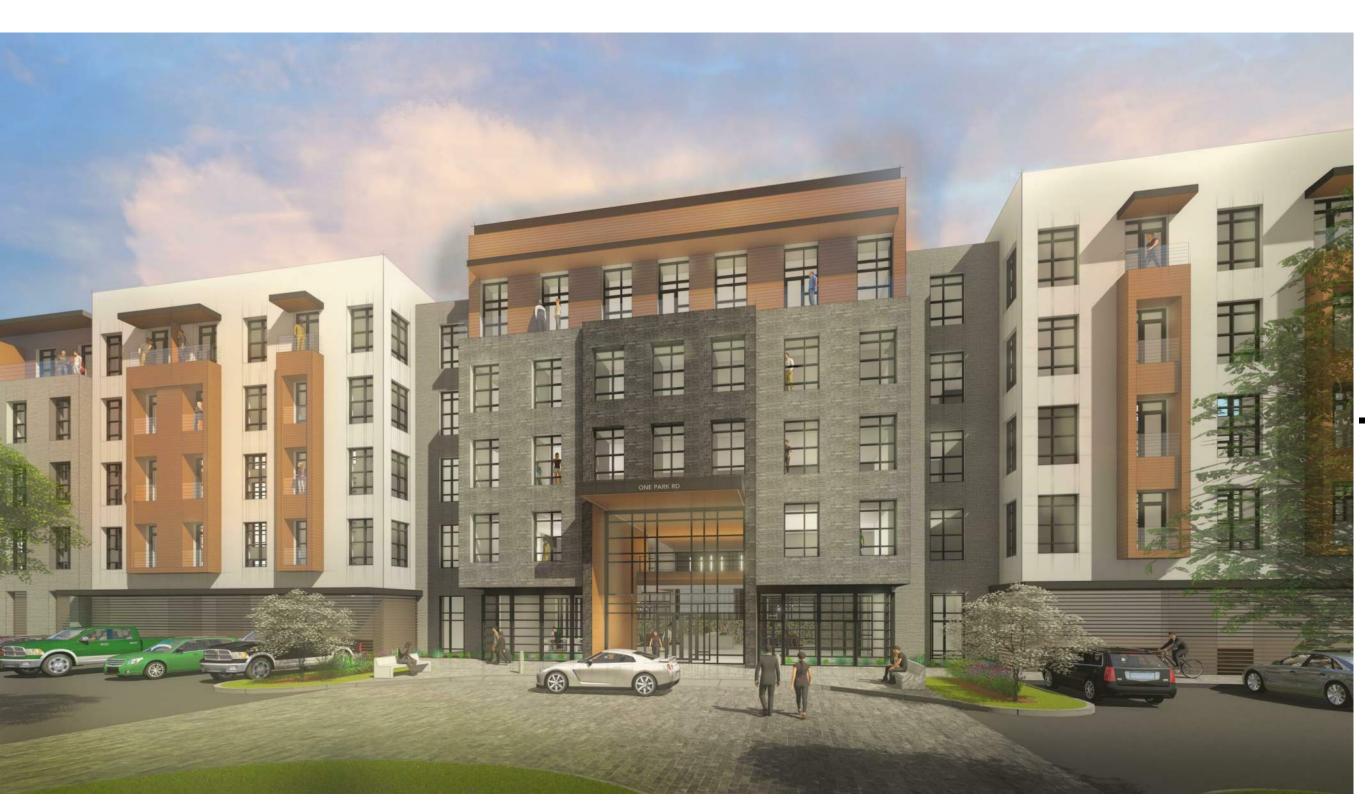


FOR PERMITTING ONLY NOT FOR CONSTRUCTION


PR	OJECT	DATA
PROJE	CT NUMBER	18036
DATE	or momber	10.26.2018
DRAWN	J	Author
CHECK	•	Checker
SCALE		onosid.
	EFERENCE C	\Users\cjr.AMENTAEMMA\Documents\18036_ONE PARK
	ROAD_C	ENTRAL_2018.2_NO_COURTYARD_UNITS_cjr.rvt
HISTOF	RY OF SUBMISSIO	NS
No.	Date	Description
01	10.26.2018	WETLANDS APPLICATION SUBMISSION
02	12.07.2018	TOWN STAFF COMMENTS UPDATES

WETLANDS & SDD APPLICATION SUBMISSION

SHEET TITLE

EXTERIOR RENDERINGS

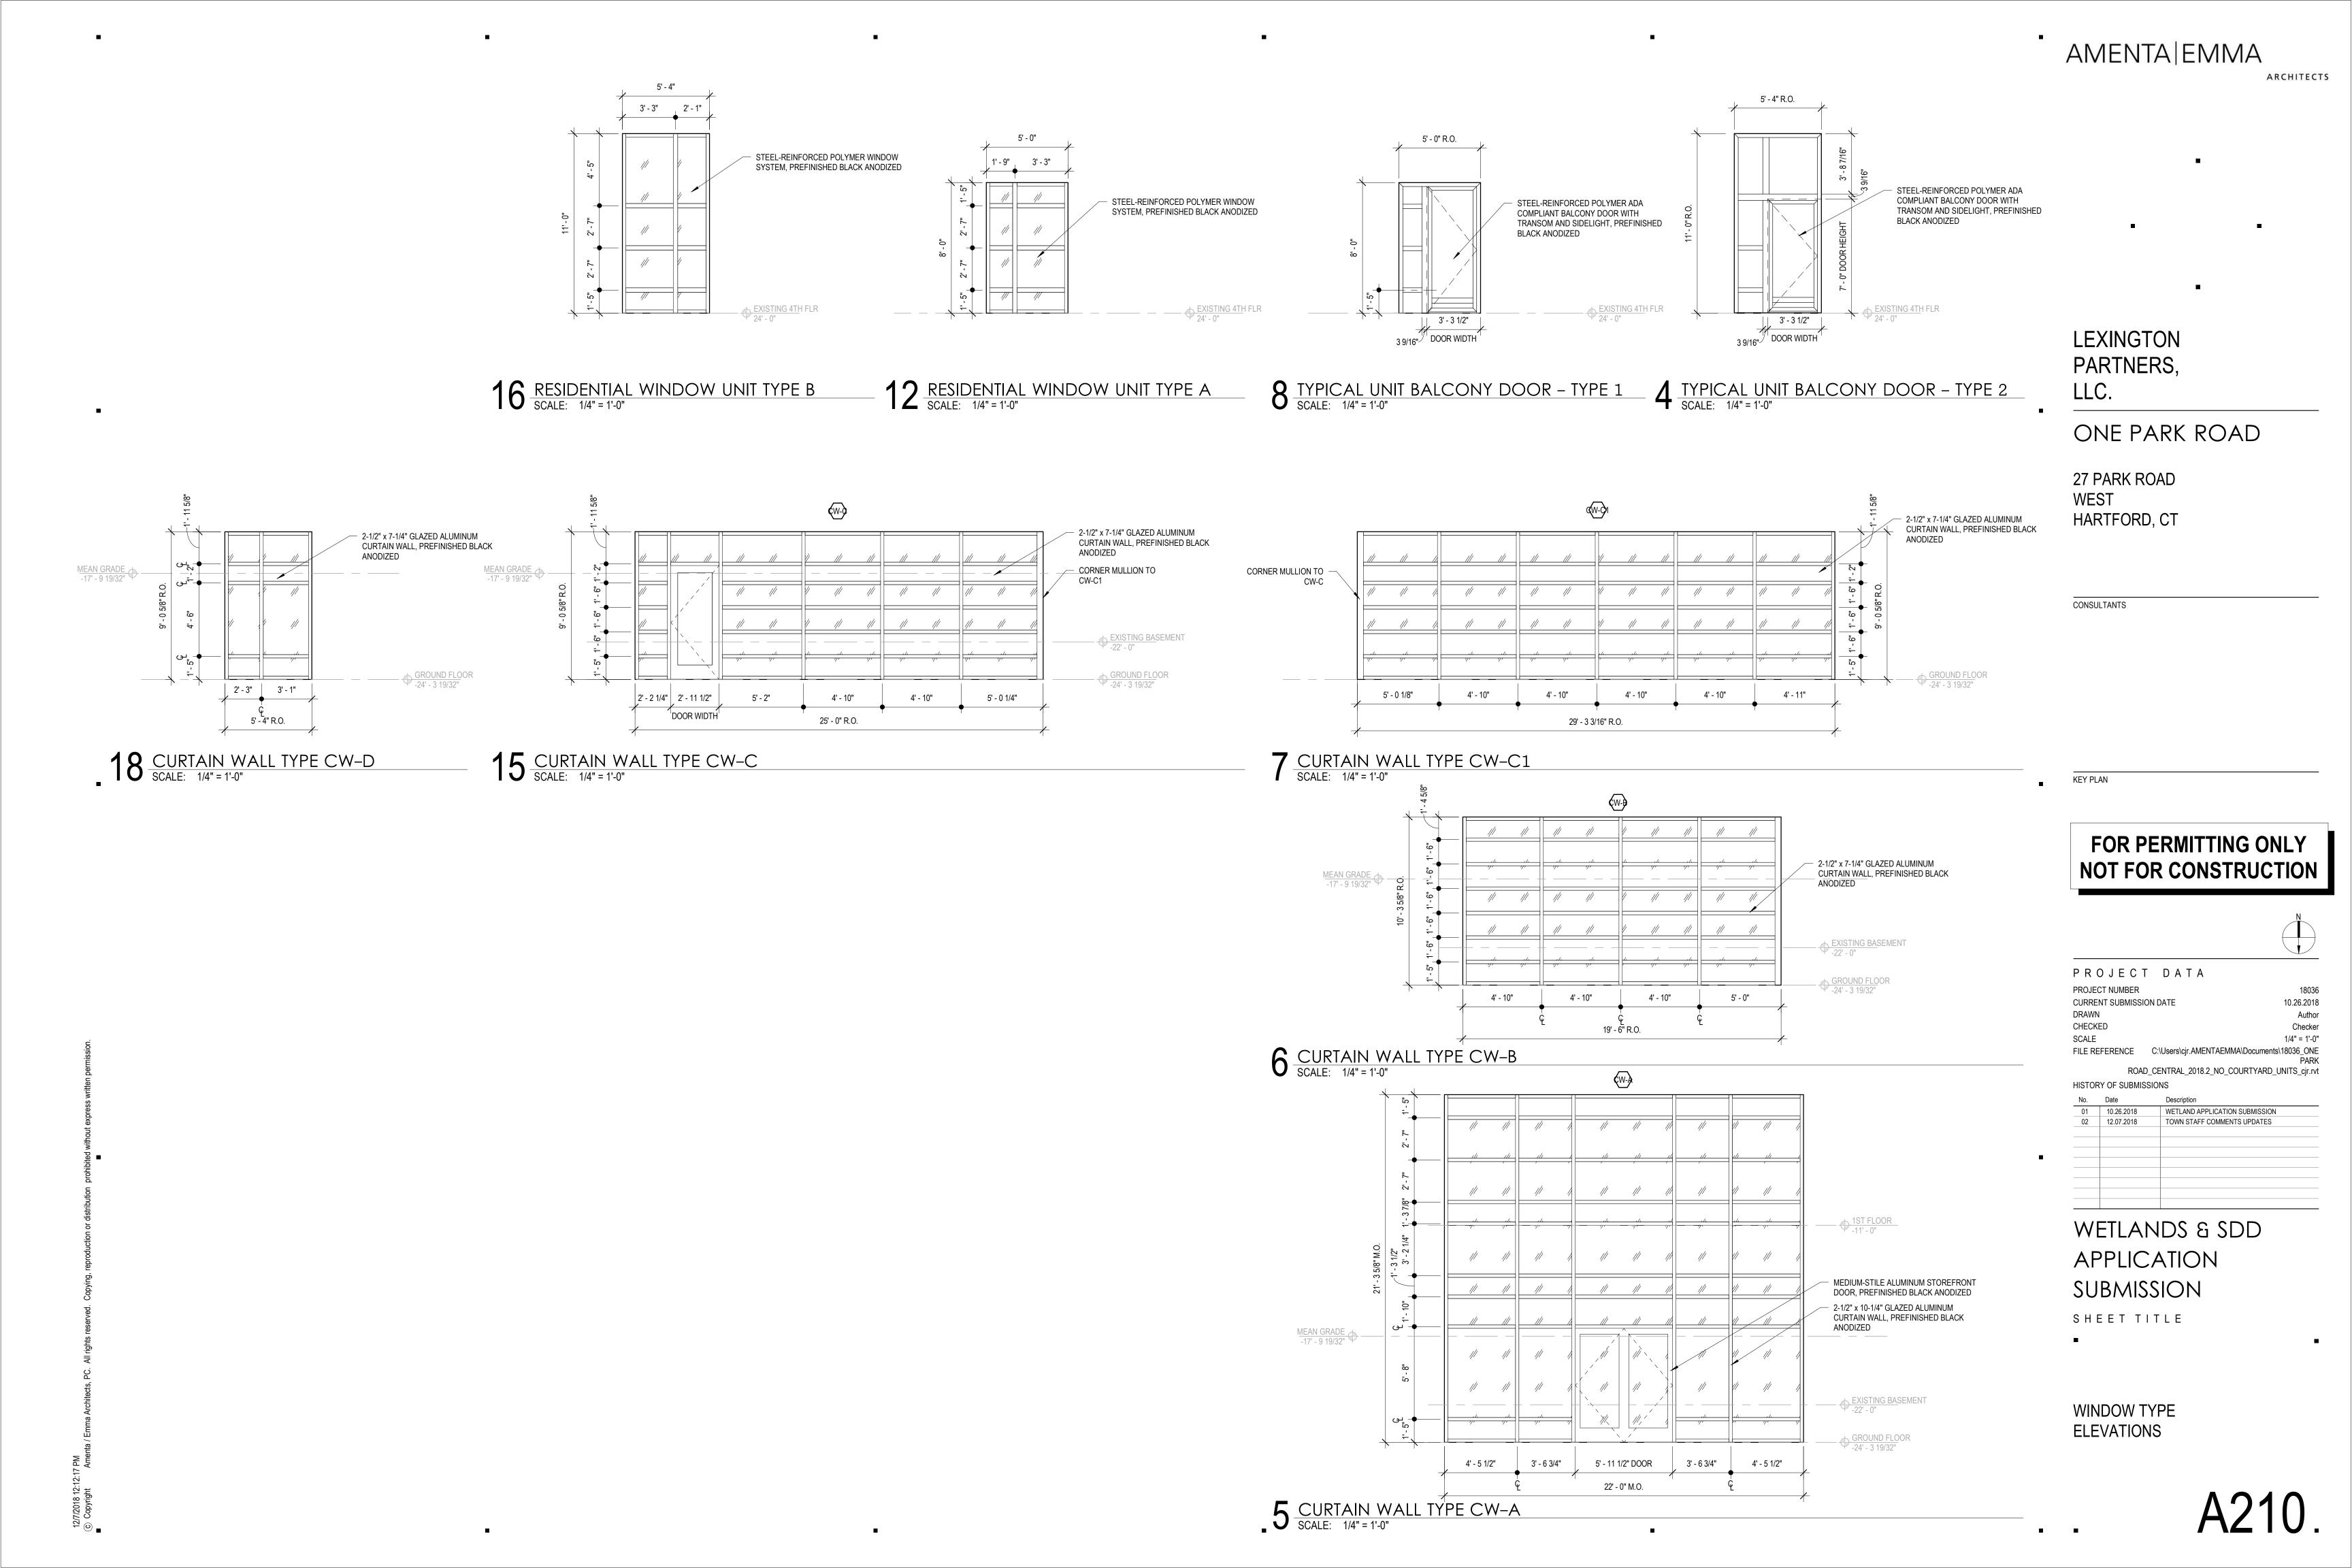

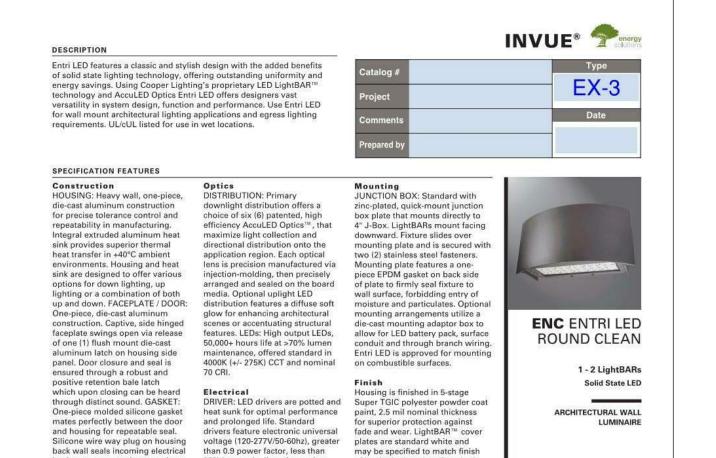

of +40°C (104°F) down to minimum white, dark platinum and graphite

may be specified to match finish

of luminaire housing. Standard

matches available. Consult Outdoo

Entri LED features a five-year limited warranty.

complete selection.

DESIGNLIGHTS

ERTIFICATION DATA

77V/50 & 60hz, 347V/60hz,

AVU092076 2013-02-27 15:56:44

80V/60hz 30°C Minimum Temperature

SHIPPING DATA Approximate Net Weight: 16 lbs. (7.3 kgs.)

METAL COMPOSITE MATERIAL METAL

HSS 3x1-1/2x1/8" HD GALVANIZED STEEL TUBE ON FLAT, HIGH-PERFORMANCE COATED TO MATCH METAL COMPOSITE

MATERIAL WALL PANEL (M2), SECURED

BRICK VENEER AS SCHEDULED, RE: EXTERIOR ELEVATIONS

BACK TO STEEL COLUMNS

FINISHED GRADE,

RE: CIVIL

(M2) CLAD CANOPY

NERGY DATA etronic LED Driver 9 Power Factor % Total Harmonic Distortio

EXIT DOOR LIGHT FIXTURE (EX-2)

back wall seals incoming electrical

leads to prevent moisture and

is impact- resistant, 5/32" thick

housing with continuous bead

tempered frosted glass sealed to

silicone gasket. Downlight lens is LED board integrated acrylic over-

hardware allow access to electrical

optics, each individually sealed for withstand 10kV of transient line

IP66 rating. HARDWARE: Stainless surge. Options to control light

steel mounting screws and latch hardware allow access to electrical levels, energy savings and egress capabilities (battery pack and

components for installation and separate circuit) are available. All


20% harmonic distortion and

starting temperature of -30°C (-22°F). Shipped standard

with Cooper Lighting proprietary circuit module designed to

mounted to a primary mounting

use of quick disconnects for ease

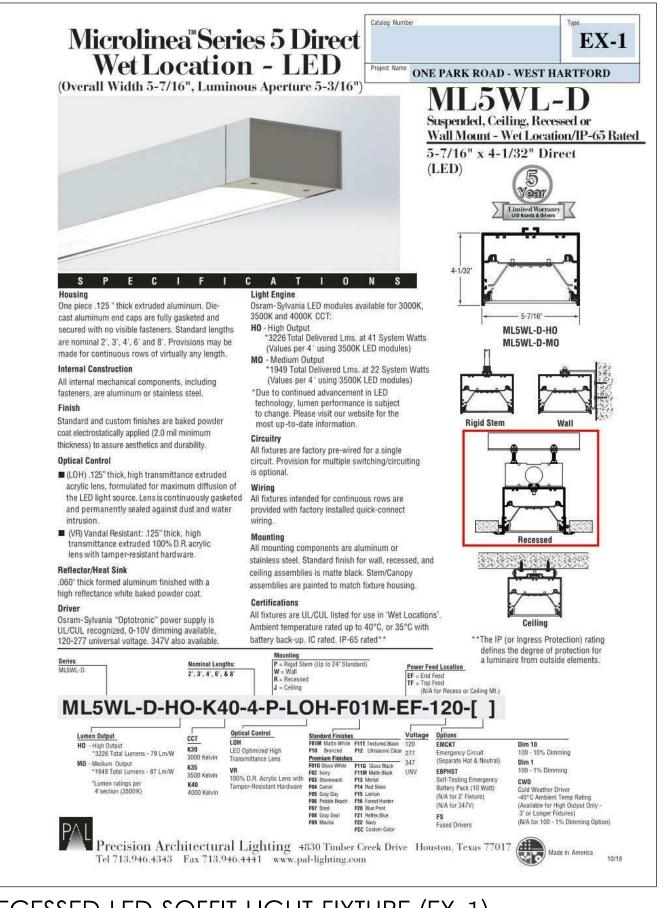

RECESSED LED SOFFIT LIGHT FIXTURE (EX-1)



8 M2 - METAL PANEL SLATS - BLACK



7 M1 - METAL PANEL SLATS - COPPER



4 B3 - FLAT GRAY



3 B2 - SLATE GRAY - SMOOTH



LEXINGTON PARTNERS,

ONE PARK ROAD

AMENTA EMMA

ARCHITECTS

27 PARK ROAD WEST HARTFORD, CT

CONSULTANTS




10 L1 - METAL LOUVER



6 C1 - CEMENTITIOUS MASONRY PRODUCT



9 B1 – SLATE GRAY – WIRE CUT

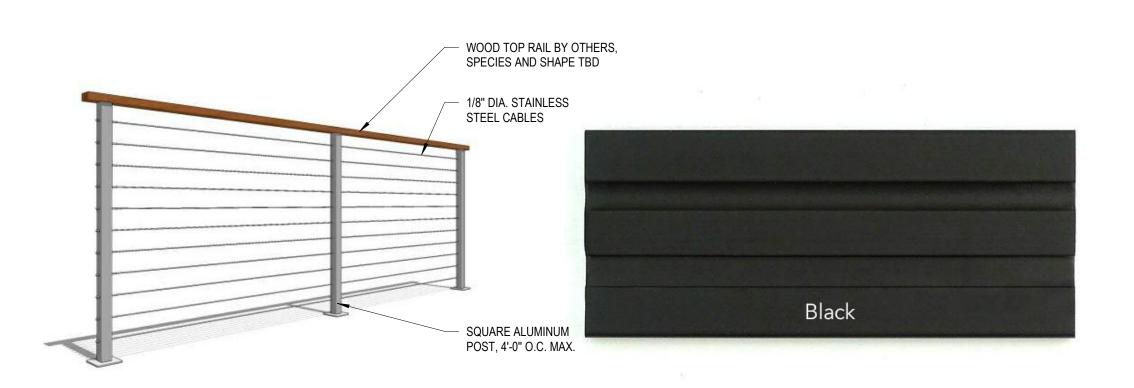

5 R1 - CABLE RAILING

A1 - ALUMINUM CLAD WINDOWS

FOR PERMITTING ONLY NOT FOR CONSTRUCTION

PROJECT DATA PROJECT NUMBER 18036 DATE 10.26.2018 DRAWN Author CHECKED Checker SCALE 1/4" = 1'-0" FILE REFERENCE C:\Users\cjr.AMENTAEMMA\Documents\18036_ONE ROAD_CENTRAL_2018.2_NO_COURTYARD_UNITS_cjr.rvt HISTORY OF SUBMISSIONS 10.26.2018 WETLANDS APPLICATION SUBMISSION TOWN STAFF COMMENTS UPDATES


WETLANDS & SDD APPLICATION SUBMISSION

SHEET TITLE

BUILDING MATERIALS

13 EXTERIOR ELEVATION - PARKING GARAGE SCREENING SCALE: 1/4" = 1'-0"



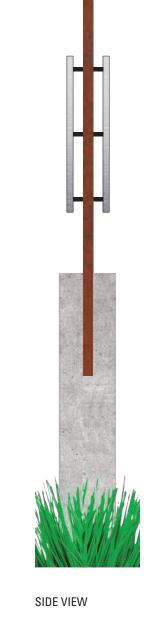



PARTNERS, LLC.

LEXINGTON

ONE PARK ROAD

27 PARK ROAD WEST HARTFORD, CT

CONSULTANTS

MONUMENT ENTRY SIGN #1 VERT 105"H X 60"W X 13.5"D


MATERIALS: CONTRETE BLOCK, CORTEN STEEL PANEL, ALUMINUM LETTERS. .25" OR .375" CUT BRUSHED ALUNIMUM LETTERS WITH 1" STANDOFF FROM CORTEN STEEL PANEL. .25" PAINTED ALUMINUM DIMENSIONAL LETTERS ON CONCRETE.





NORTH ELEVATION

SIDE VIEW

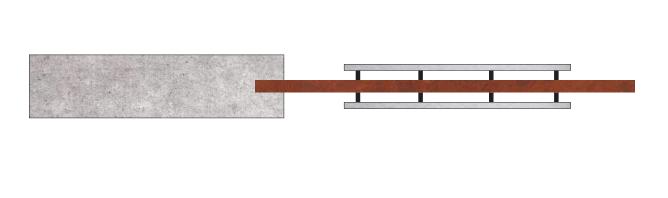



SITE LOCATIONS - CORNER OF PROSPEC AND PARK PARK ROAD ENTRY

PLAN VIEW

MONUMENT ENTRY SIGN #1 60"H X 112"W X 13.5"D MATERIALS: CONTRETE BLOCK, CORTEN STEEL PANEL, ALUMINUM LETTERS. .25" OR .375" CUT BRUSHED ALUNIMUM LETTERS WITH 1" STANDOFF FROM CORTEN STEEL PANEL. .25" PAINTED ALUMINUM DIMENSIONAL LETTERS ON CONCRETE.

FOR PERMITTING ONLY NOT FOR CONSTRUCTION

PROJECT DATA PROJECT NUMBER 10.26.2018 CHECKED SCALE FILE REFERENCE C:\Users\cdl.AMENTAEMMA\Documents\18036_ONE ROAD_CENTRAL_2018.2_NO_COURTYARD_UNITS_chrislegiadre4215.rvt HISTORY OF SUBMISSIONS TOWN STAFF COMMENT UPDATES

WETLANDS & SDD APPLICATION SUBMISSION

SHEET TITLE


EXTERIOR SIGNAGE



MATERIAL: BRUSHED ALUMINUM

BUILDING SIGN 60"H X 84.5"W X 3"D

SIGNAGE: BRUSHED ALUMINUM DIMENSIONAL LETTERS SUSPENDED FROM CANOPY

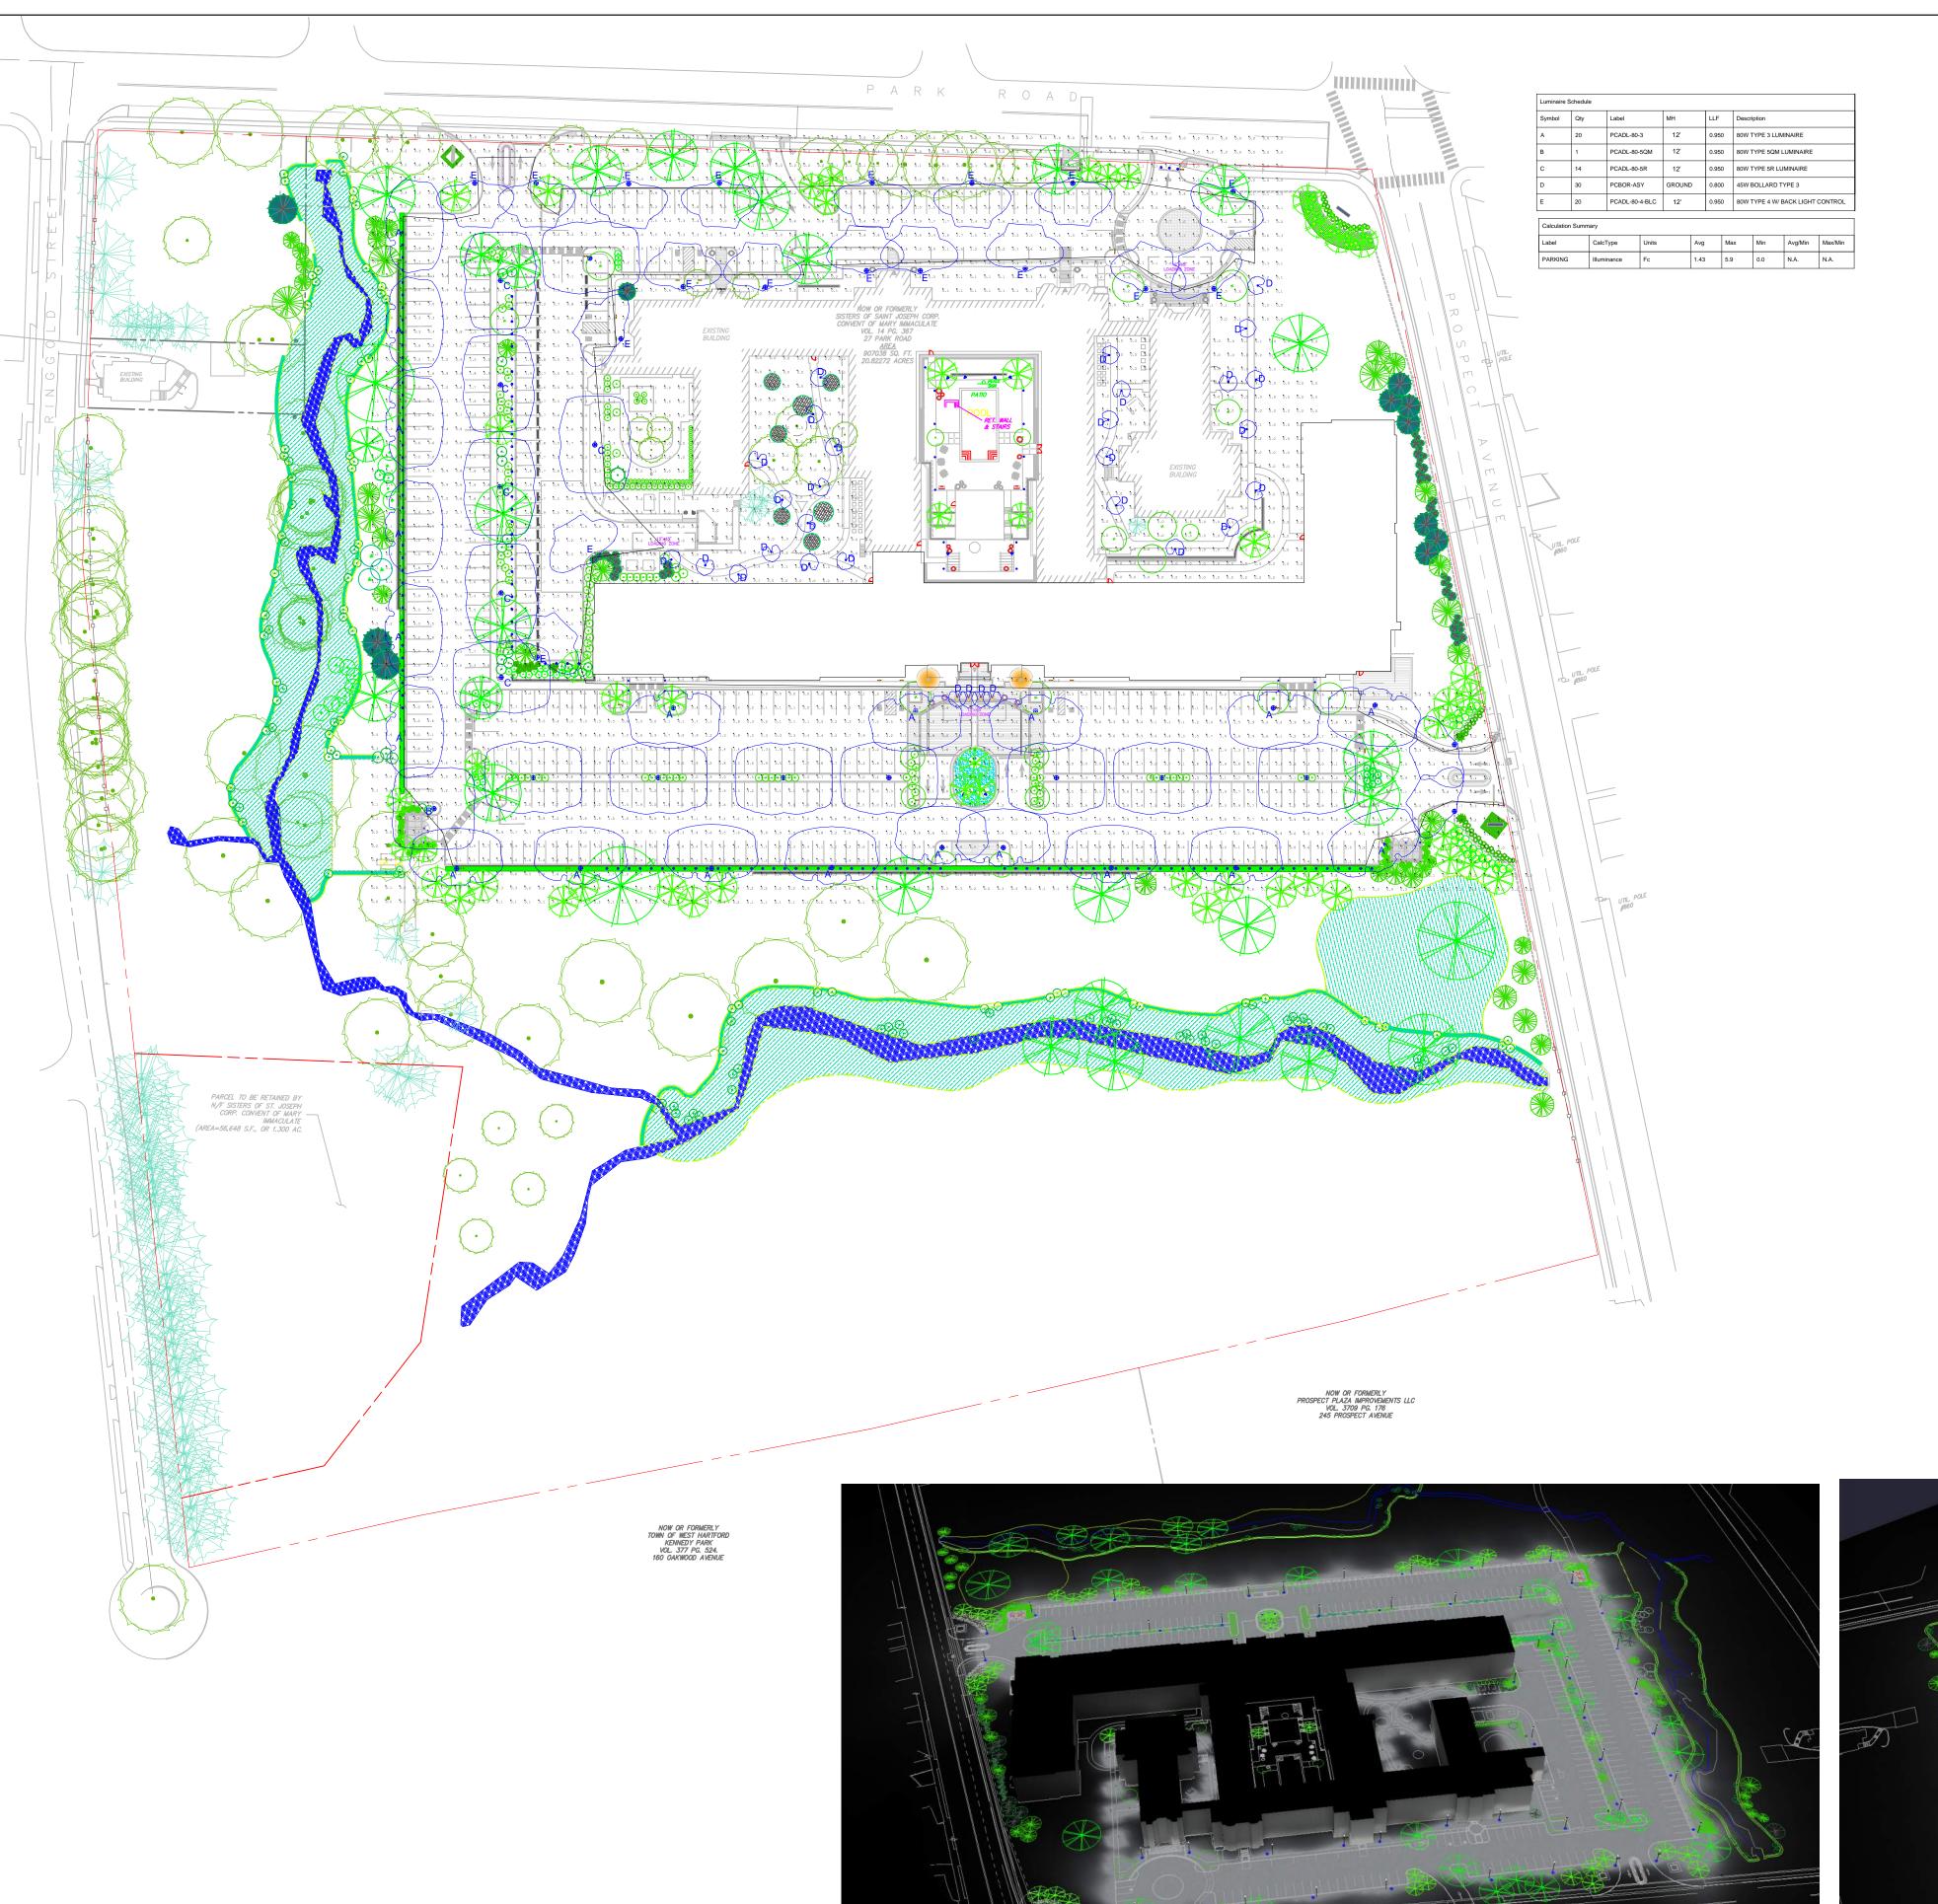

PCAD SERIES

SPECIFICATIONS

Intended Use:

The Beacon Urban luminaire is available with a choice of different LED wattage configurations, shapes, sizes and optical distributions

• Available with Energeni for optional set dimming, timed dimming with simple dela or timed dimming based on time of night designed to replace HID lighting up to 400W MH or HPS.

- The drivers shall be located in the top cast housing and shall be accessible without tools by hinging the lower shade assembly. The driver and all electrical
- components shall be on a tray.

 The lower shade shall be made from a onepiece aluminum spinning.

 The housing is designed for LED thermal management without the use of metallic screens, cages, or fans. The top casting shall be able to be pendent mounted in place with a stainless steel safety pin and then permanently held in place with four stainless steel bolts.

• 100V through 277V, 50 Hz to 60 Hz (UNV), or

- 347V or 480V input. Power factor is ≥0.90 at full load.
- Dimming drivers are standard with connections for external dimming equipment available upon request. Component-to-component wiring within the luminaire may carry no more than 80% of rated load and is listed by UL for use at

Fixture electrical compartment shall contain all

shall activate at a specific, factory-preset temperature, and progressively reduce power over a finite temperature range. A luminaire equipped with the device may be reliably

operated in any ambient temperature up to 55°C (131°F). Operation shall be smooth and undetectable to the eye. Thermal circuit is designed to "fail on", allowing the luminaire to revert to full power in the event of an interruption of its power supply, or faulty wiring connection to the drivers. The device shall be able to co-exist with other 0-10V control devices (occupancy sensors, external

LED driver components.

- 600VAC at 50°C or higher. IDA approved Plug disconnects are listed by UL for use at 600 VAC, 13A or higher. 13A rating applies to This product is approved by the Florida Fish and Wildlife Conservation Commission. primary (AC) side only. Separate spec available at
- Button photocell available. Ambient operating temperature -40°C to 40°C
 Five year limited warranty for more information Surge protection - 20KA. Lifeshield™ Circuit - protects luminaire from excessive temperature. The device www.hubbelllighting.com/resources/warranty

Certifications:

Controls/Options:

for more details

IFS polyester powder-coat

dimming, timed dimming with simple delay, or timed dimming based on time of night

• Urban can be specified with **SiteSync™** wireless control system for reduction in energy and maintenance cost while

optimizing light quality 24/7. See ordering

information or visit:
www.hubbelllighting.com/products/sitesync

electrostatically applied and thermocured. IFS finish consists of a five stage

TGIC polyester powder coat finish. • The finish meets the AAMA 605.2 performance specification which includes

pretreatment regimen with a polymer primer sealer and top coated with a thermoset super

surface impacts of up to 160 inch-pounds.

consult DLC website for more details: http://

DesignLights Consortium (DLC) qualified,

www.designlights.org/QPL
• NRTL Certified, UL8750, UL 1598 and

CSA22.2#250. 13-14 for wet locations


http://www.beaconproducts.com/products/urban

PRODUCT IMAGE(S)

LED Area Designer Lighting




passing a 3000 hour salt spray test for corrosion resistance and resists cracking or loss of adhesion per ASTM D522 and resists STYLES

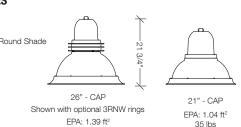

Shown with SiteSync™

EPA: 1.00 ft²

MRDS - Deep Shade

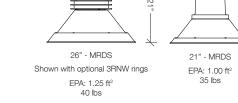

26" - MAR Shown with optional 3RNW rings

EPA: 1.25 ft²

CERTIFICATIONS/LISTINGS

dimmers, etc.).

PCBO SERIES

Specifications:

- Extruded aluminum square or round housing, with tamper resistant hardware; Flat top, for round. Single screw access for top relamping. Sealed one-piece, clear acrylic lens; Specular anodized aluminum optical systems; dual reflector or
- Concealed, galvanized steel anchor base; Four ½" x 10" anchor bolts
- · Durable Lektrocote® TGIC thermoset polyester powder coat paint finish assures long life and maintenance-free service All models standard as 4000K CCT

Electrical:

- Universal voltage (120-277V) drivers with +/- 10% tolerance, starting temperature rated at -20°C
- Rotatable LED assembly adjustment for ideal placement and aiming of symmetric light pattern 24 high brightness LEDs at 500 mA deliver symmetric distribution at 46 Watts • 12 high brightness LEDs at 700 mA deliver asymmetric distribution at 31 Watts


Warranty:

5 year limited warranty for LED system.

Listing/Certification:

Walkway Lighting



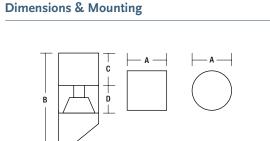

	Α	В	C	D	Weigh
Square	6.75" sq.	42.0"	6.0"	4.0"	41 lb:
'		1067 mm	152 mm	102 mm	19 kg
Round	7.0" dia	42.0"	6.0"	4.0"	41 lb:
	170	1067	150	100	101

CONFORMANCE TO FACILITY CODE AND OTHER LOCAL REQUIREMENTS IS THE RESPONSIBILITY OF THE OWNER AND/OR THE OWNER'S REPRESENTATIVE.

	4.	ALL DIMENSIONS ARE IN FEET UNLESS OTHERWISE INDICA		
			REVISION SCHEDULE	
	R	ΕV	DESCRIPTION	DATE

SITE UPDATES

12.19.18

GENERAL NOTES

THIS LIGHTING DESIGN IS BASED ON LIMITED INFORMATION SUPPLIED BY OTHERS TO PROGRESS COMMERCIAL. SITE

DETAILS PROVIDED HEREIN ARE REPRODUCED ONLY AS A VISUALIZATION AID. FIELD DEVIATIONS MAY SIGNIFICANTLY AFFECT PREDICTED PERFORMANCE. PRIOR TO INSTALLATION.

CRITICAL SITE INFORMATION (POLE LOCATIONS, ORIENTATION

MOUNTING HEIGHT, ETC) SHOULD BE COORDINATED WITH TH CONTRACTOR AND/OR SPECIFIER RESPONSIBLE FOR THE PROJECT.

LUMINAIRE DATA IS TESTED TO INDUSTRY STANDARDS UNDER

LABORATORY CONDITIONS. OPERATING VOLTAGE AND NORMAL MANUFACTURING TOLERANCES OF LAMP, BALLAST, AND LUMINAIRE MAY AFFECT FIELD RESULTS.

CLIENT CONSTRUCTION COST SOLUTIONS KEN WOODWARD KW.CCSOLUTIONS@GMAIL.COM

860.748.0718 ACCOUNT MANAGER

JARED SOUZA JSOUZA@PROGRESSLIGHTING.COM 508.207.5809 **TERRITORY 599** PROJECT NUMBER

112618OP REV A

DATE	12.19.18
DRAWN BY	APRU
SCALE	NTS
PAGE	1 OF 1






XX/XX XX
DESIGNER REVIEWER No. DATE DESCRIPTION

DATUM: GRAPHIC SCALE

SEAL

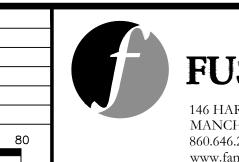

HORZ.: 1" = 80'

VERT.:

HORZ.:

FUSS&O'NEILL 146 HARTFORD ROAD MANCHESTER, CONNECTICUT 06040 860.646.2469 www.fando.com

LEXINGTON PARTNERS, SISTERS OF SAINT JOSEPH PARK RD. AT PROSPECT AVE. INTERSECTION SIGHT DISTANCE PLAN


1 PARK ROAD

CONNECTICUT WEST HARTFORD

PROJ. No.: 20180539.A10
DATE: DECEMBER 2018

ISD-01

XX/XX DESCRIPTION DESIGNER REVIEWER No. DATE

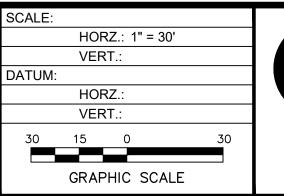



www.fando.com

LEXINGTON PARTNERS, SISTERS OF SAINT JOSEPH PARK RD. AT PROSPECT AVE. INTERSECTION PAVEMENT MARKING PLAN

1 PARK ROAD

PVT-01

DATE: DECEMBER 2018

WEST HARTFORD

CONNECTICUT